

5B-01 STAIRWELL #14A

	LUMINAIRE SCHEDULE											
TYPE	MANUFACTURERS	CATALOG INFORMATION	FIXTURE DESCRIPTION	LAMP DATA		BALLAST DATA	INPUT	VOLTAGE	MOUNTING	REMARKS		
				NO.	TYPE	NO.	TYPE	WATTS	1 102102	III O O I I I I I I I I I I I I I I I I	, <u>, , , , , , , , , , , , , , , , , , </u>	
	METALUX OR EQUAL		1'X4' LINEAR FLUORESCENT WRAP AROUND FIXTURE. COLD ROLLED STEEL HOUSING. WHITE POLYESTER POWDER COAT PAINT ON ALL METAL PARTS, CORROSION RESISTANT FINISH.	2	28W T8 SP41	1	ELECTRONIC	58	120	WALL		
A2	METALUX OR EQUAL		1'X4' LINEAR FLUORESCENT WRAP AROUND FIXTURE. COLD ROLLED STEEL HOUSING. WHITE POLYESTER POWDER COAT PAINT ON ALL METAL PARTS, CORROSION RESISTANT FINISH.	2	28W T8 SP41	1	ELECTRONIC	58	120	SURFACE		
E1	SURE-LITES OR EQUAL		SOLID, DIE—CAST ALUMINUM HOUSING, WHITE ALUMINUM FACING WITH WHITE HOUSING, RED LETTERING. UNIVERSAL MOUNTING. AC ONLY.		INCLUDED			1.5	120	UNIVERSAL		

DISCONNECT POWER TO EXISTING EXHAUST FAN FOR RELOCATION BY MECHANICAL CONTRACTOR. (2) PROVIDE CONNECTION TO RELOCATED EXHAUST FAN,

EXTEND CONDUIT AND CONDUCTORS AS REQUIRED. (3) PROVIDE 120V CONNECTION TO NEAREST LIFE SAFETY PANEL ON THE FOURTH FLOOR, PROVIDE NEW 20A BREAKER IN PANEL. ONLY ONE CIRCUIT REQUIRED FOR ATTIC SPACE.

4 PROVIDE 120V CONNECTION TO UNIT HEATER FAN, CONNECT TO NEAREST ADEQUATE NORMAL POWER

ALTERNATE BID #1.

5 CONNECT EXISTING LIGHT FIXTURE TO LIFE SAFETY

(6) CONNECT TO EXISTING STAIRWELL LIGHTING CIRCUIT.

(7) DELETE ALL WORK WITHIN BOUNDARY UNDER DEDUCT

(8) EMERGENCY LIGHTING RELAY, SEE DETAIL 5/E1.

PLAN NOTES (CONTINUED):

10 DISCONNECT AND REMOVE EXISTING LIGHT FIXTURE, SALVAGE FOR REINSTALLATION. (11) DISCONNECT AND REMOVE EXISTING WIRELESS ACCESS


POINT, SALVAGE FOR REINSTALLATION. (12) WALL MOUNT SALVAGED LIGHT FIXTURE UNDER NEW

STAIR TO LIGHT 4TH FLOOR LANDING BELOW.
CONNECT TO EXISTING STAIRWELL CIRCUIT. 13 INSTALL SALVAGED WIRELESS ACCESS POINT ON UNDERSIDE ON NEW LANDING, VERIFY LOCATION WITH

14) INSTALL SALVAGED LIGHT FIXTURE ON UNDERSIDE OF NEW LANDING, RE—CONNECT TO EXISTING LIFE SAFETY

(15) TO EXISTING NORMAL POWER CIRCUIT.

(16) WALL MOUNT NEW FIXTURE UNDER NEW STAIR TO LIGHT 4TH FLOOR LANDING BELOW. CONNECT TO EXISTING LIFE SAFETY STAIRWELL CIRCUIT.

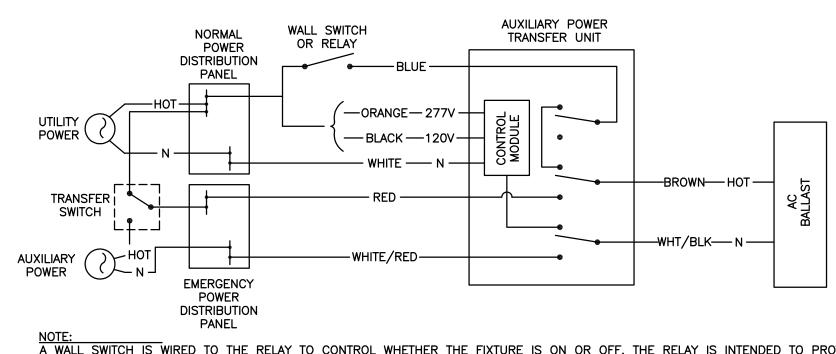


NOTE:


A WALL SWITCH IS WIRED TO THE RELAY TO CONTROL WHETHER THE FIXTURE IS ON OR OFF. THE RELAY IS INTENDED TO PROVIDE THE FIXTURE POWER FROM A NORMAL PANEL DURING NORMAL OPERATING CONDITIONS. IN THE EVENT OF LOSS OF POWER, THE RELAY IS TO PROVIDE POWER FROM A LIFE SAFETY PANEL. WHEN NORMAL POWER RETURNS, THE RELAY IS TO RETURN NORMAL POWER OF SWITCHING REMAINED POWERED AT ALL TIMES. POWER TO THE FIXTURE. ALL EXIT FIXTURES ARE TO BE WIRED AHEAD OF SWITCHING REMAINED POWERED AT ALL TIMES.


5 EMERGENCY RELAY ONE-LINE DIAGRAM

REMODELING PLAN

REMODELING PLAN

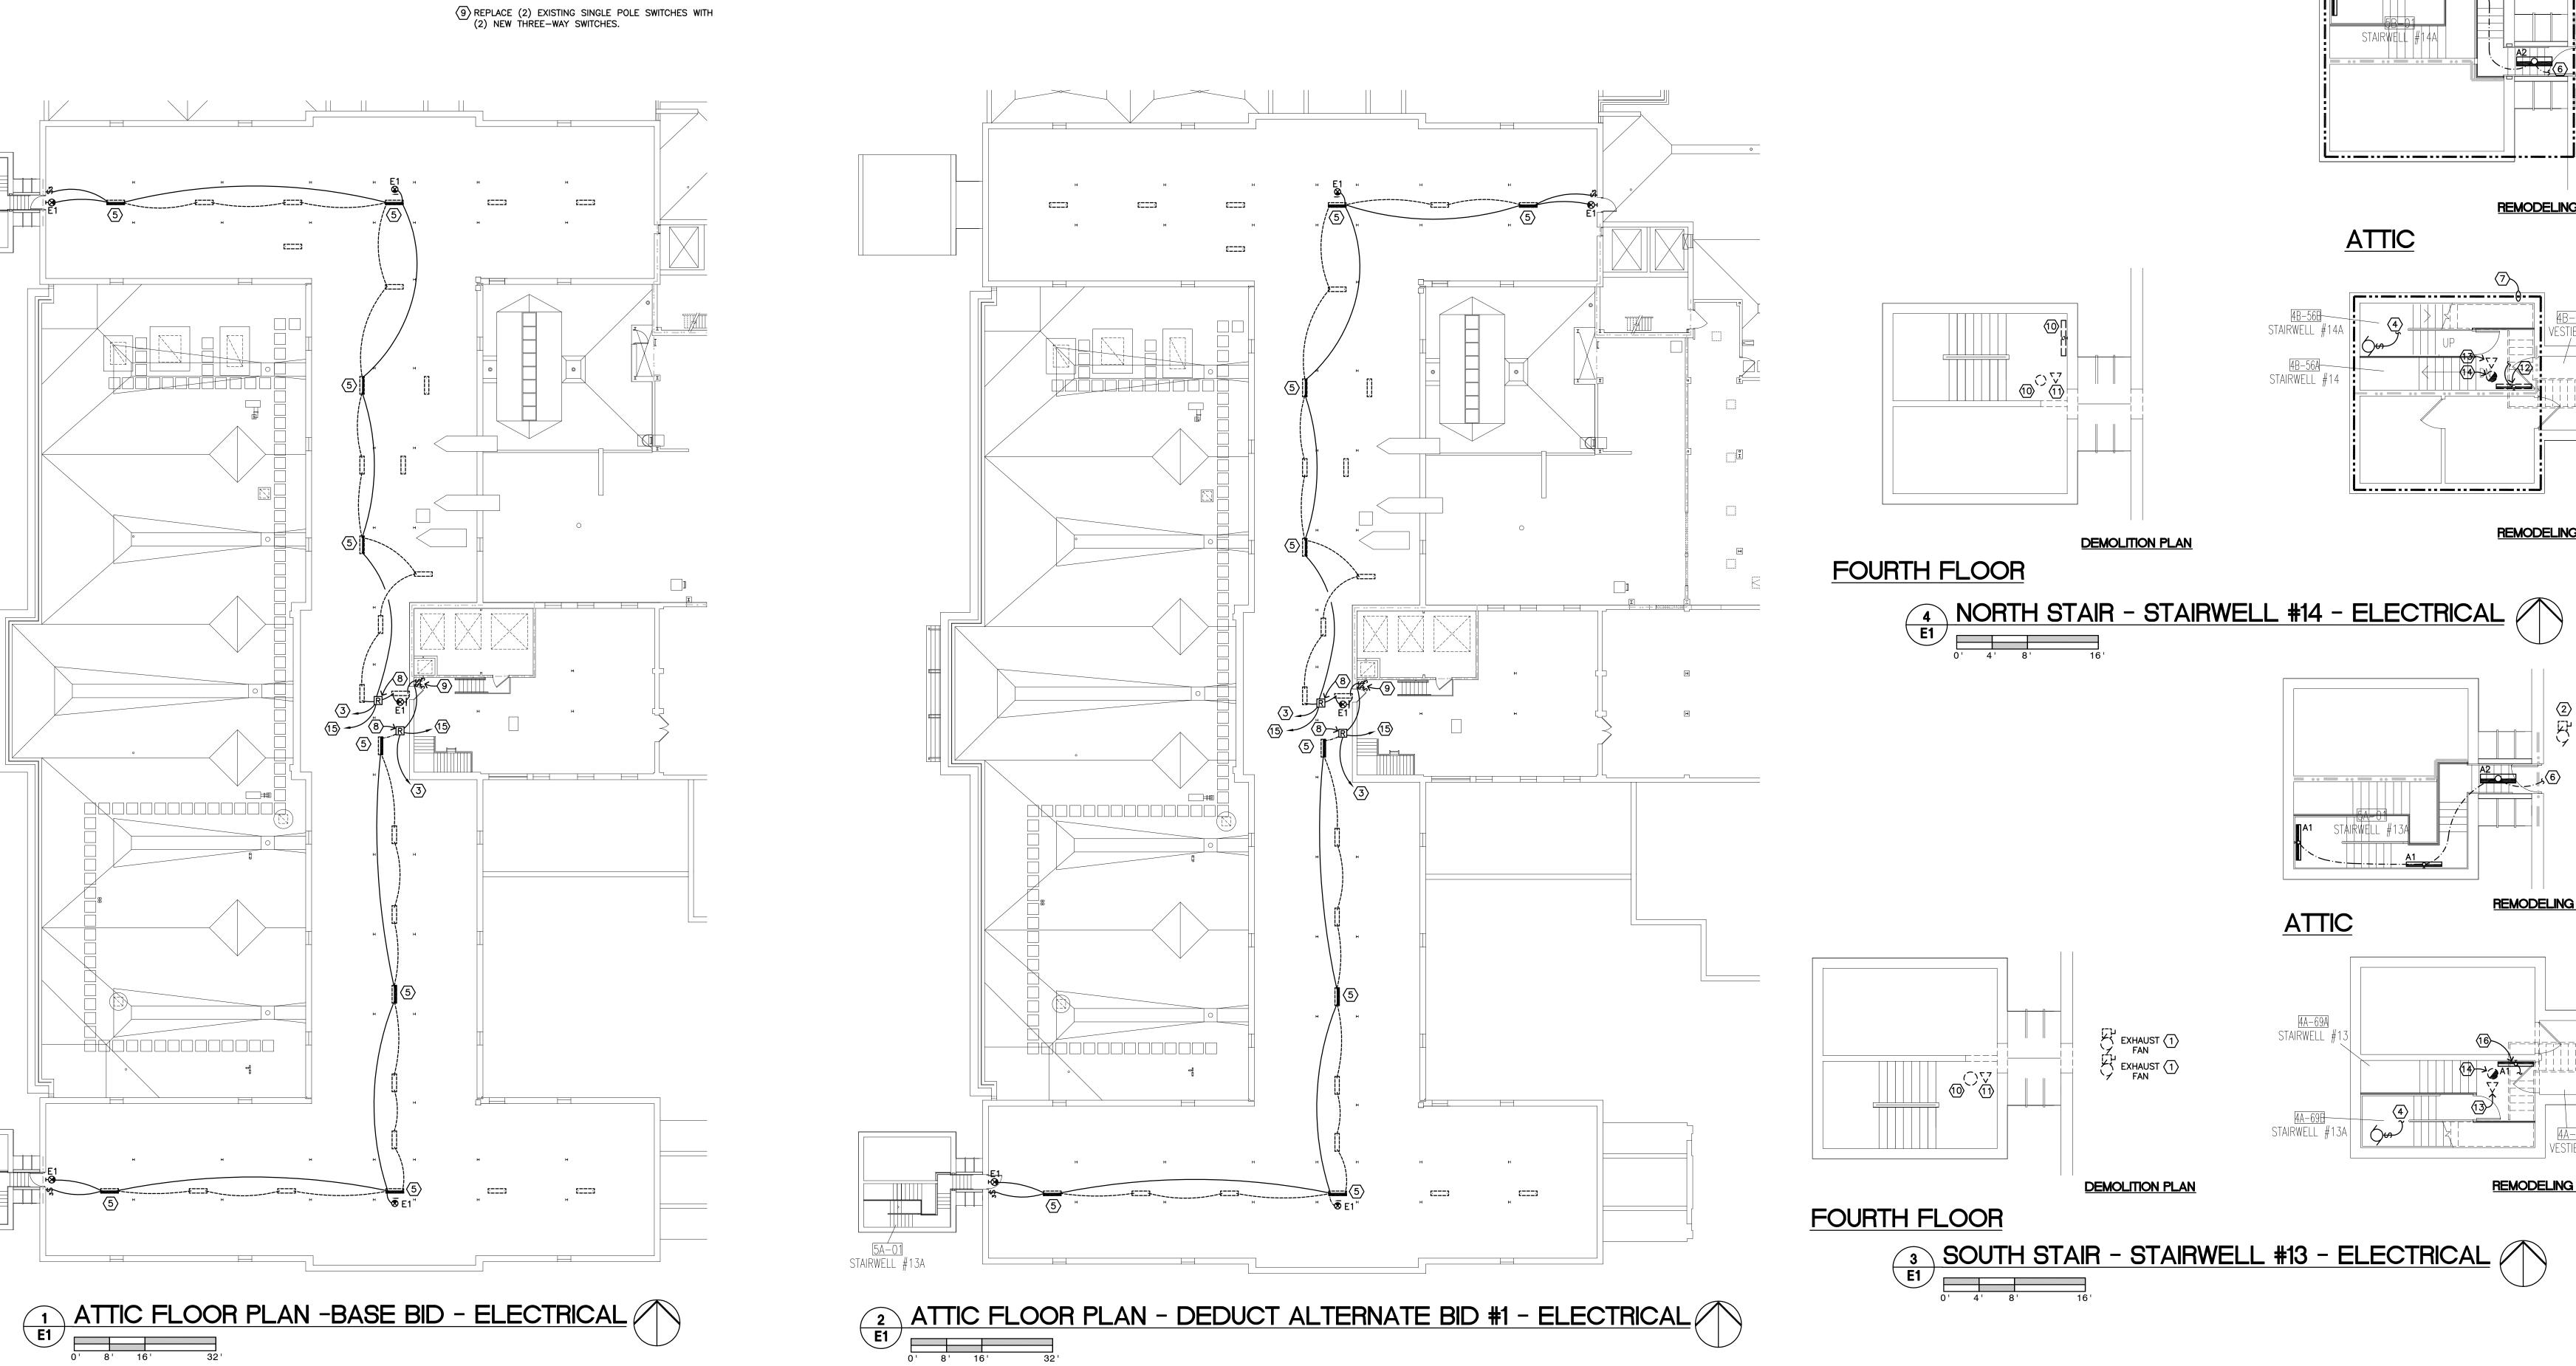

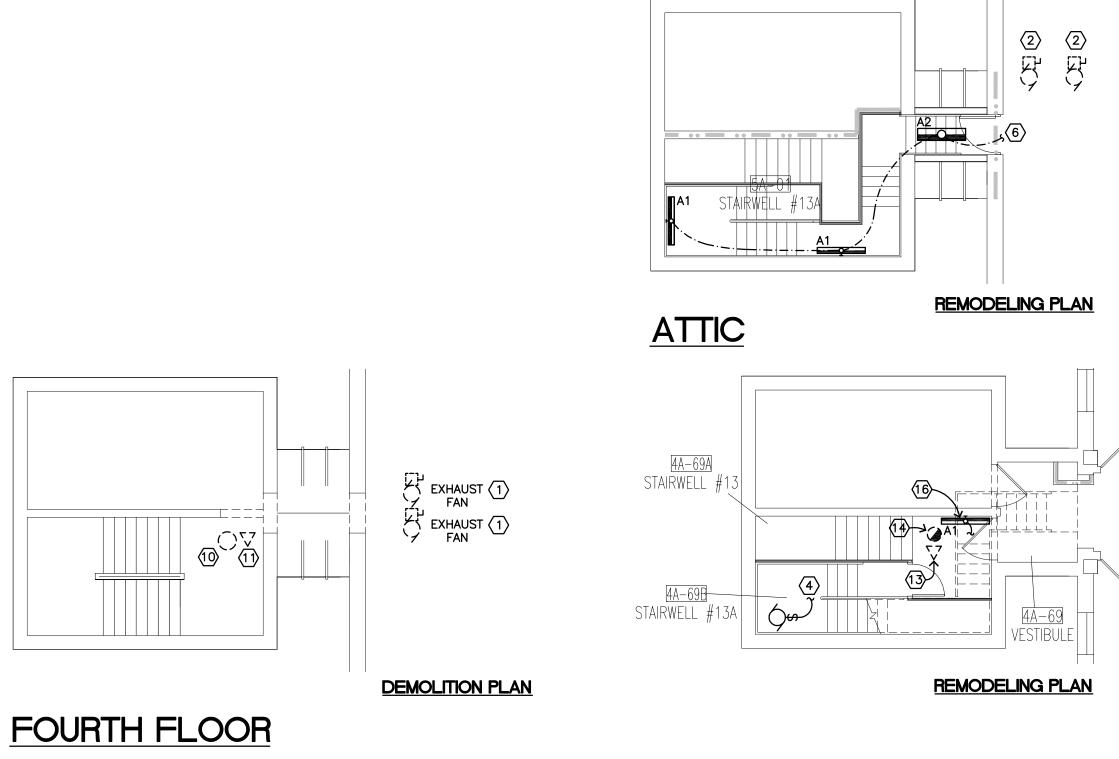

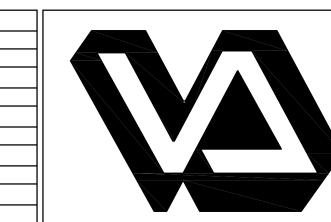

Date

Dept. of Veterans Affairs Health Care System 2101 Elm Street North Fargo, ND 58102



503 7th St N, SUITE 200 FARGO, ND 58102 PHONE: 701.478.6336 FAX: 701.478.6340

IMAGE GROUP INC., Architecture & Interiors OBERMILLER NELSON ENGINEERING, Mechanical Engineers MBN ENGINEERING, Electrical Engineers



awing Title OURTH FLOOR		Project Title	V ATTIO/DENTILIO	MARCH 12, 2014	of airs	
LANS - ELECT EMOLITION AN	RICAL D REMODELING	MODIFY ATTIC/PENTHOUSE			Scale AS NOTED	ment of ns Affairs
Project No. 437-14-101	Contract No. VA263-P-1217 VA263-C-	Designed By	Checked By	Drawn By	Drawing No.	Depart Vetera
ilding No. 1, 9, 46	AutoCAD File Name 14-008 E1.dwg	FARGO VA HEALTH CARE SYSTEM FARGO, ND			L I Dwg. 9 of 9	8